
# TOWN CENTER (a) AQUIA DRIVE-THRU RESTAURANT 2840 JEFFERSON DAVIS HIGHWAY

(GENERALIZED DEVELOPMENT PLAN)

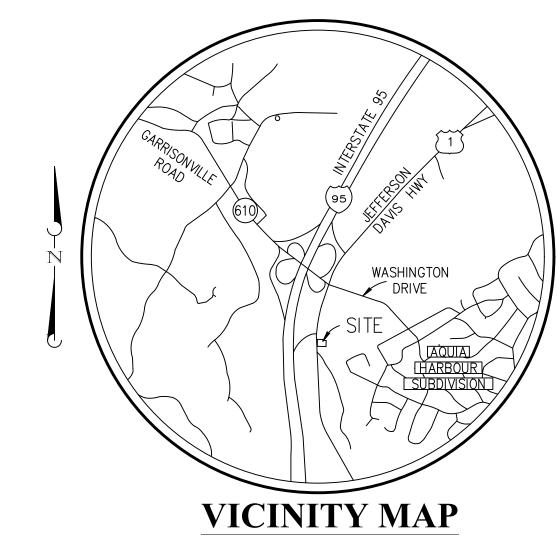

1'' = 2,000'

## **ENGINEER:**

FREDERICKSBURG, VA 22408 PHONE (540) 373-5178

OWNER/APPLICANT:

13409 STRAW BALE LANE LR# 160005354

SITE ADDRESS:

T.M. 21CC-2

#### LEGEND SANITARY BUILDING SEW SEWER SHT CENTERLINE SHEET CLEAN OUT SIDEWALK CONCRETE **SQFT** SQUARE FEET (FOOT) CORRUGATED METAL PIPE STD STANDARD CURB & GUTTER STM STORM DEED BOOK T & S TAP AND SLEEVE DEMOLISH TM TAX MAP DIP DUCTILE IRON PIPE TEL TELEPHONE EASEMENT TBR TO BE REMOVED/RELOCATED EDGE OF PAVEMENT TOP OF CURB ELEV **ELEVATION** TRAN TRANSFORMER END SECTION TYP TYPICAL END WALL UNDERGROUND UG **EXISTING** IV UNDERGROUND ELECTRIC, TELEPHONE, TELEVISION FINISHED GRADE UTILITY POLE FINISHED FLOOR **VERT** VERTICAL FIRE HYDRANT WATER LINE FORCE MAIN WATER METER GAS LINE WV WATER VALVE GAS METER GROSS FLOOR AREA W/LWATERLINE HANDICAPPED HIGH DENSITY POLYETHYLENE PIPE ACCESSIBLE HIGH POINT **HORZ** HORIZONTAL ——98—— EXISTING INTERMEDIATE CONTOUR INVERT IRON PIPE FOUND ——100 — EXISTING INDEX CONTOUR IRON PIPE SET 276.93 EXISTING SPOT SHOT LIGHT POLE MANHOLE MAXIMUM ----50 + FINISHED GRADE MINIMUM FINISHED SPOT SHOT OVERHEAD ELECTRIC OVERHEAD ELECTRIC, TELEPHONE OHE,T,TV OVERHEAD ELECTRIC, TELEPHONE, TELEVISION FIRE HYDRANT **PVMT** PAVEMENT LIGHT POLES PED PEDESTAL PERFORATED SIGNS PROPOSED POLYVINYL CHLORIDE TEST PIT RADIUS REDUCER REINFORCED CONCRETE PIPE RD ROOF DRAIN RETAINING WALL

# **SHEET INDEX**

SHEET NUMBER:


COVER SHEET **EXISTING CONDITIONS** 

- GENERALIZED DEVELOPMENT PLAN
- LANDSCAPING PLAN
- REGULATING PLAN (BY OTHERS AND FOR INFORMATION ONLY)
- REGULATING PLAN (BY OTHERS AND FOR INFORMATION ONLY) REGULATING PLAN (BY OTHERS AND FOR INFORMATION ONLY)

### GENERAL NOTES


- 1. LOT LINES ASSOCIATED WITH EACH BUILDING AREA WILL BE ESTABLISHED WITH FINAL SITE PLAN
- 2. STREET LIGHTS WILL BE IN ACCORDANCE WITH THE STAFFORD COUNTY ZONING ORDINANCE.
- 3. THE PROJECT WILL BE SERVED BY PUBLIC WATER AND SEWER.
- 4. METES AND BOUNDS SHOWN HEREON ARE THE RESULT OF A CURRENT FIELD BOUNDARY SURVEY PERFORMED BY ALEXANDRIA SURVEYS, SURVEYS DATED JANUARY 8, 2016.
- 5. EXISTING ZONE: PTN-D; USE: VACANT.
- 6. ALL EXISTING STRUCTURES HAVE BEEN REMOVED.
- 7. THE PROPERTY SHOWN HEREON LIES WITHIN UNSHADED FLOOD HAZARD ZONE "X", AREAS DETERMINED TO BE OUTSIDE THE 0.2% ANNUAL CHANCE FLOODPLAIN, AS DEPICTED ON FLOOD INSURANCE RATE MAP, COMMUNITY PANEL #51179C0134F, HAVING AN EFFECTIVE DATE OF FEBRUARY 18, 2015 AND PREPARED BY THE FEDERAL EMERGENCY MANAGEMENT AGENCY.
- 8. THERE ARE NO KNOWN RESOURCE PROTECTION AREAS, WETLANDS OR CEMETERIES ON THE SITE
- 9. A TRAFFIC IMPACT ANALYSIS (TIA) WAS NOT PREPARED FOR THIS APPLICATION BECAUSE THE PROPOSED USE WAS INCLUDED IN A MUCH LARGER PROJECT THAT PREPARE A TIA IN 2007. THE PROPOSED DENSITY FOR THE LARGER PROJECT WAS SIGNIFICANTLY MORE INTENSE THAN WHAT IS CURRENTLY CONSTRUCTED AND
- BEING PROPOSED. HENCE IMPACTS FROM THIS APPLICATION ARE NEGLIGIBLE. 10. DUMPSTER FENCES SHALL BE A MINIMUM OF SIX FOOT TALL AND CONSIST OF BOARD ON BOARD
- 11. GDP IS FOR ILLUSTRATIVE PURPOSES ONLY AND THAT IT IS NOT BEING REVIEWED FOR FULL
- COMPLIANCE WITH THE ZONING ORDINANCE AT THIS TIME
- 12. AQUIA HARBOR VOLUNTEER RESCUE SQUAD, DISTANCE IS 0.5 MILE.




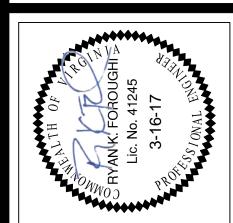


12/14/2016 DESIGNED BY: DRAWN BY: CHECKED BY: FILE NAME: 20534-1MODEL

PLAN NO.

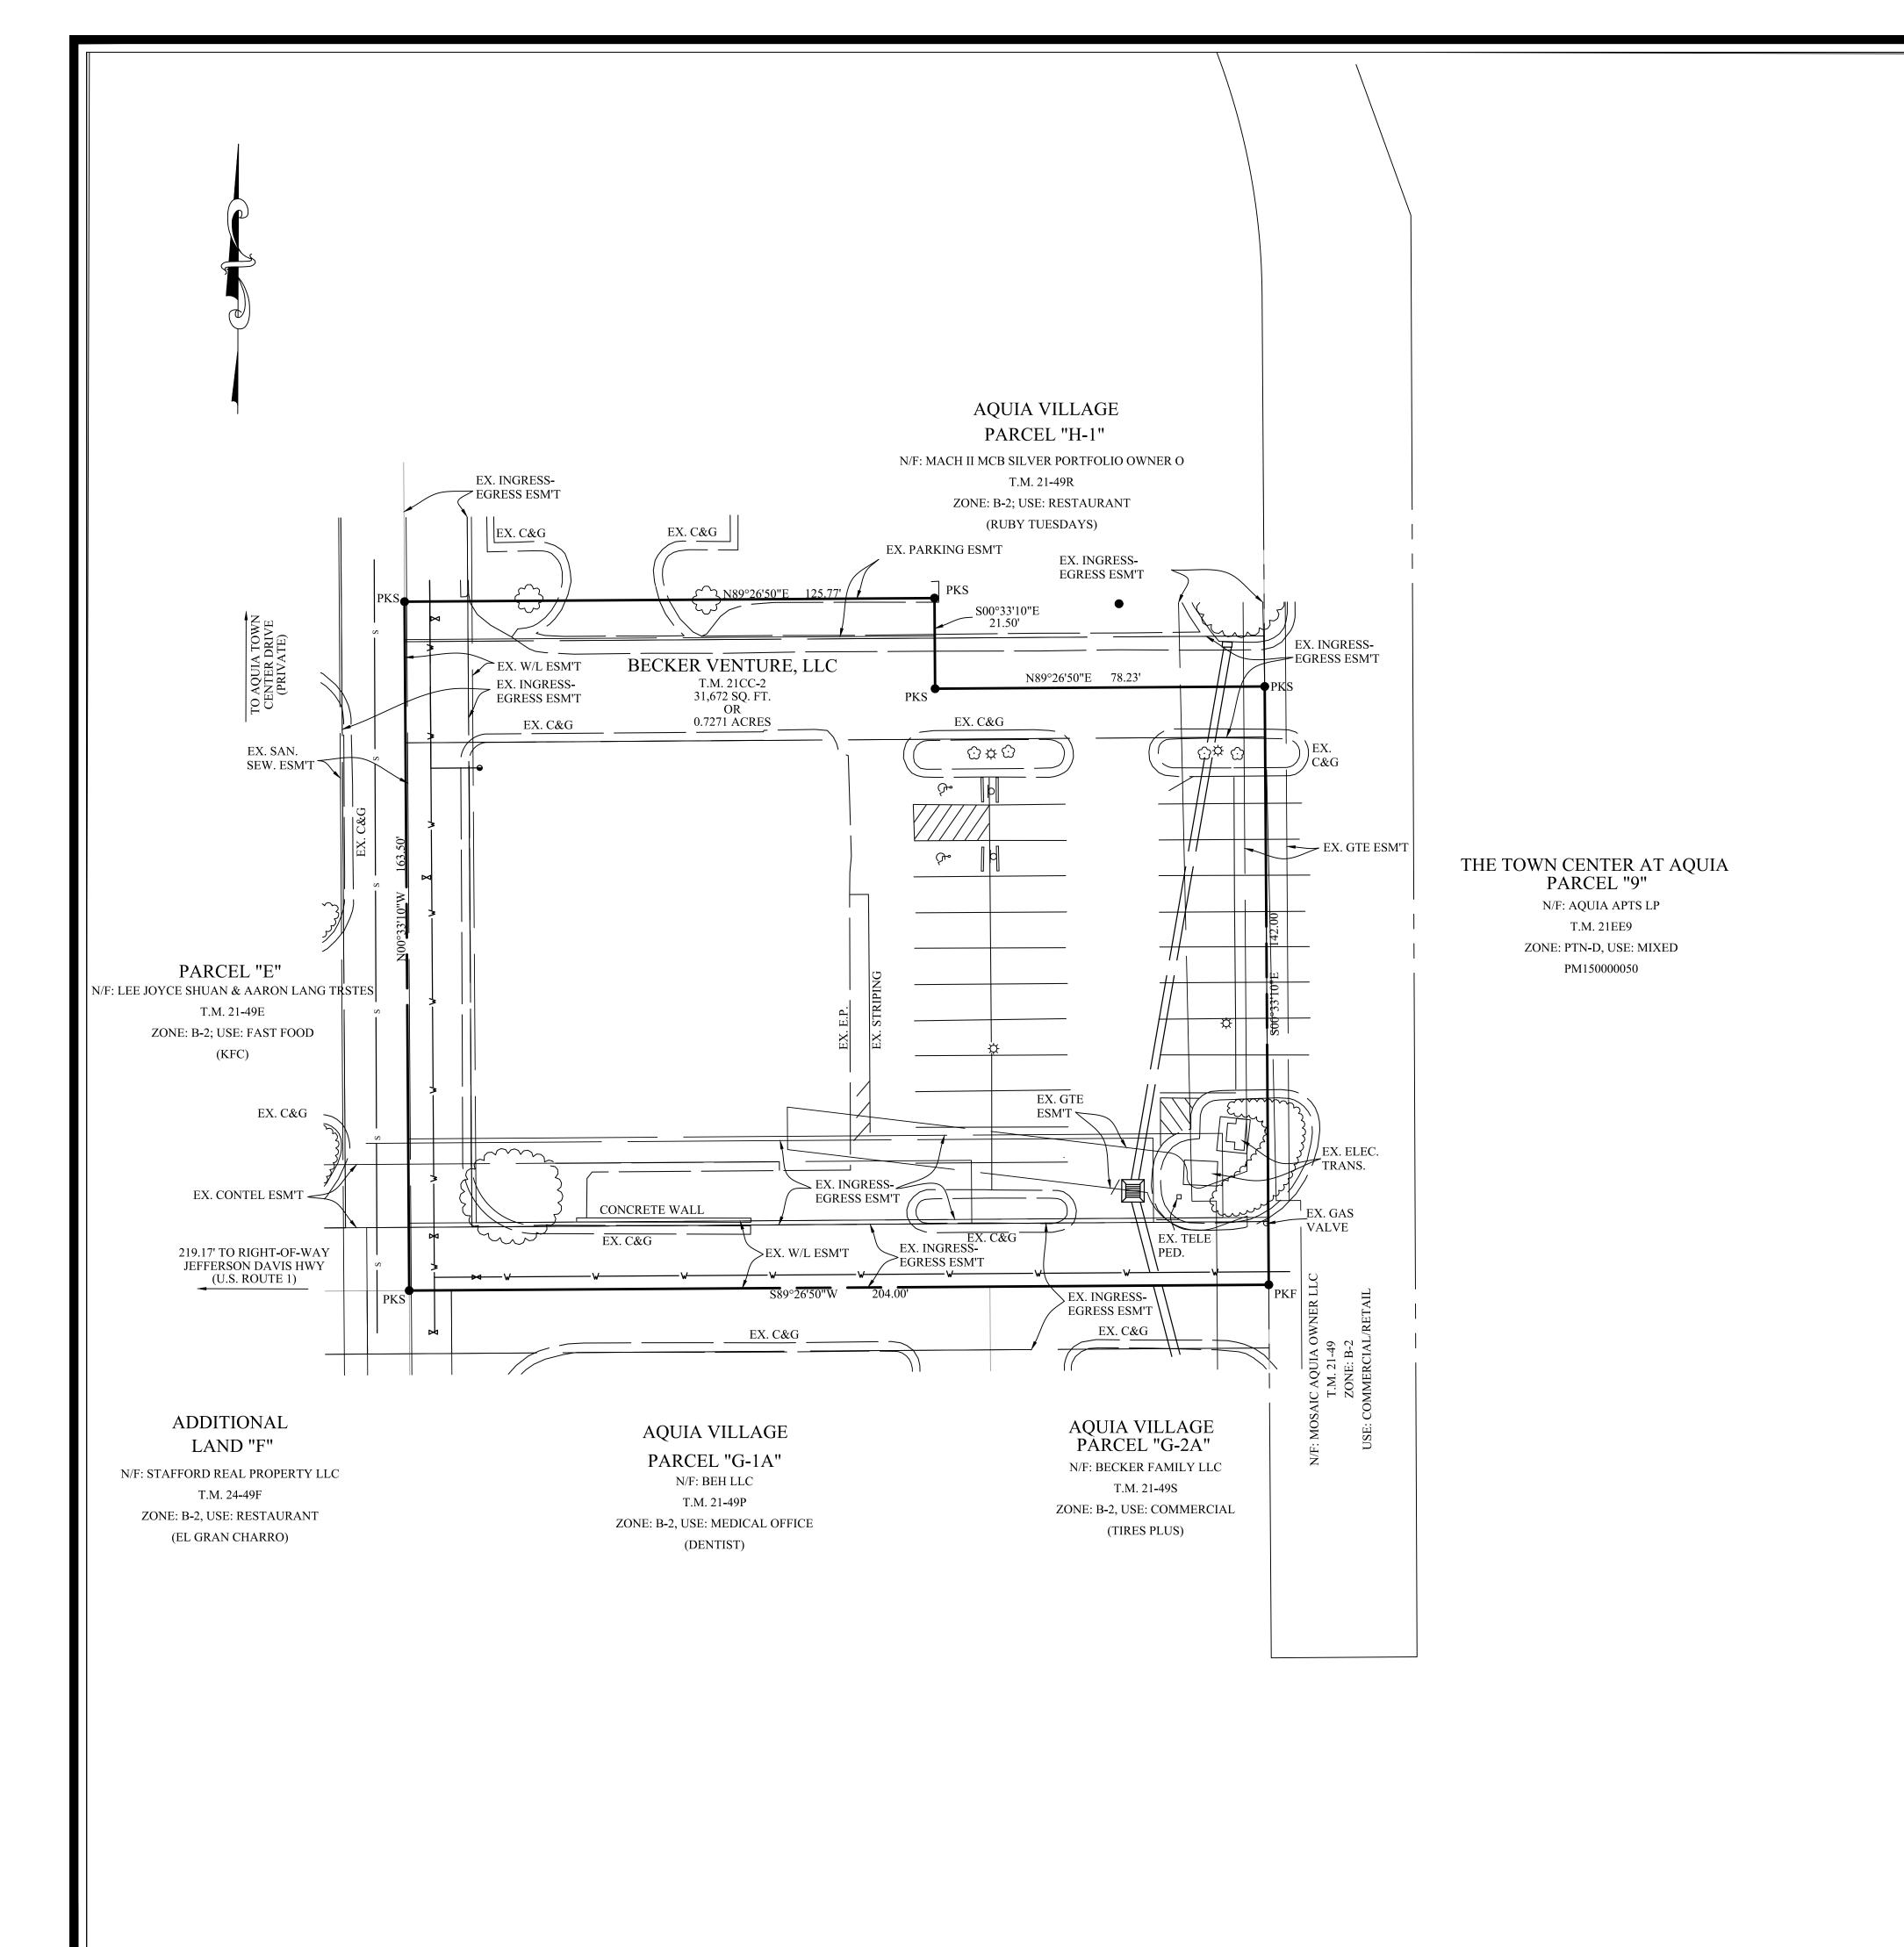

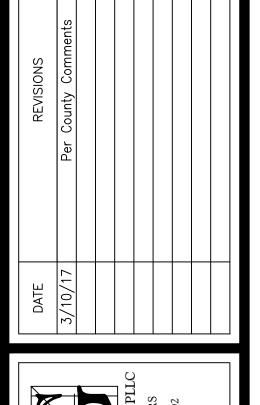



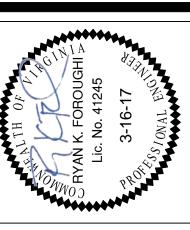


12/14/2016 1" = 20'RFK

SCALE: DESIGNED BY: RKF DRAWN BY: RFK CHECKED BY:

> FILE NAME: 20534-1MODEL 20534-1 PLAN NO.

GRAPHIC SCALE

( IN FEET ) 1 inch = 20 ft.

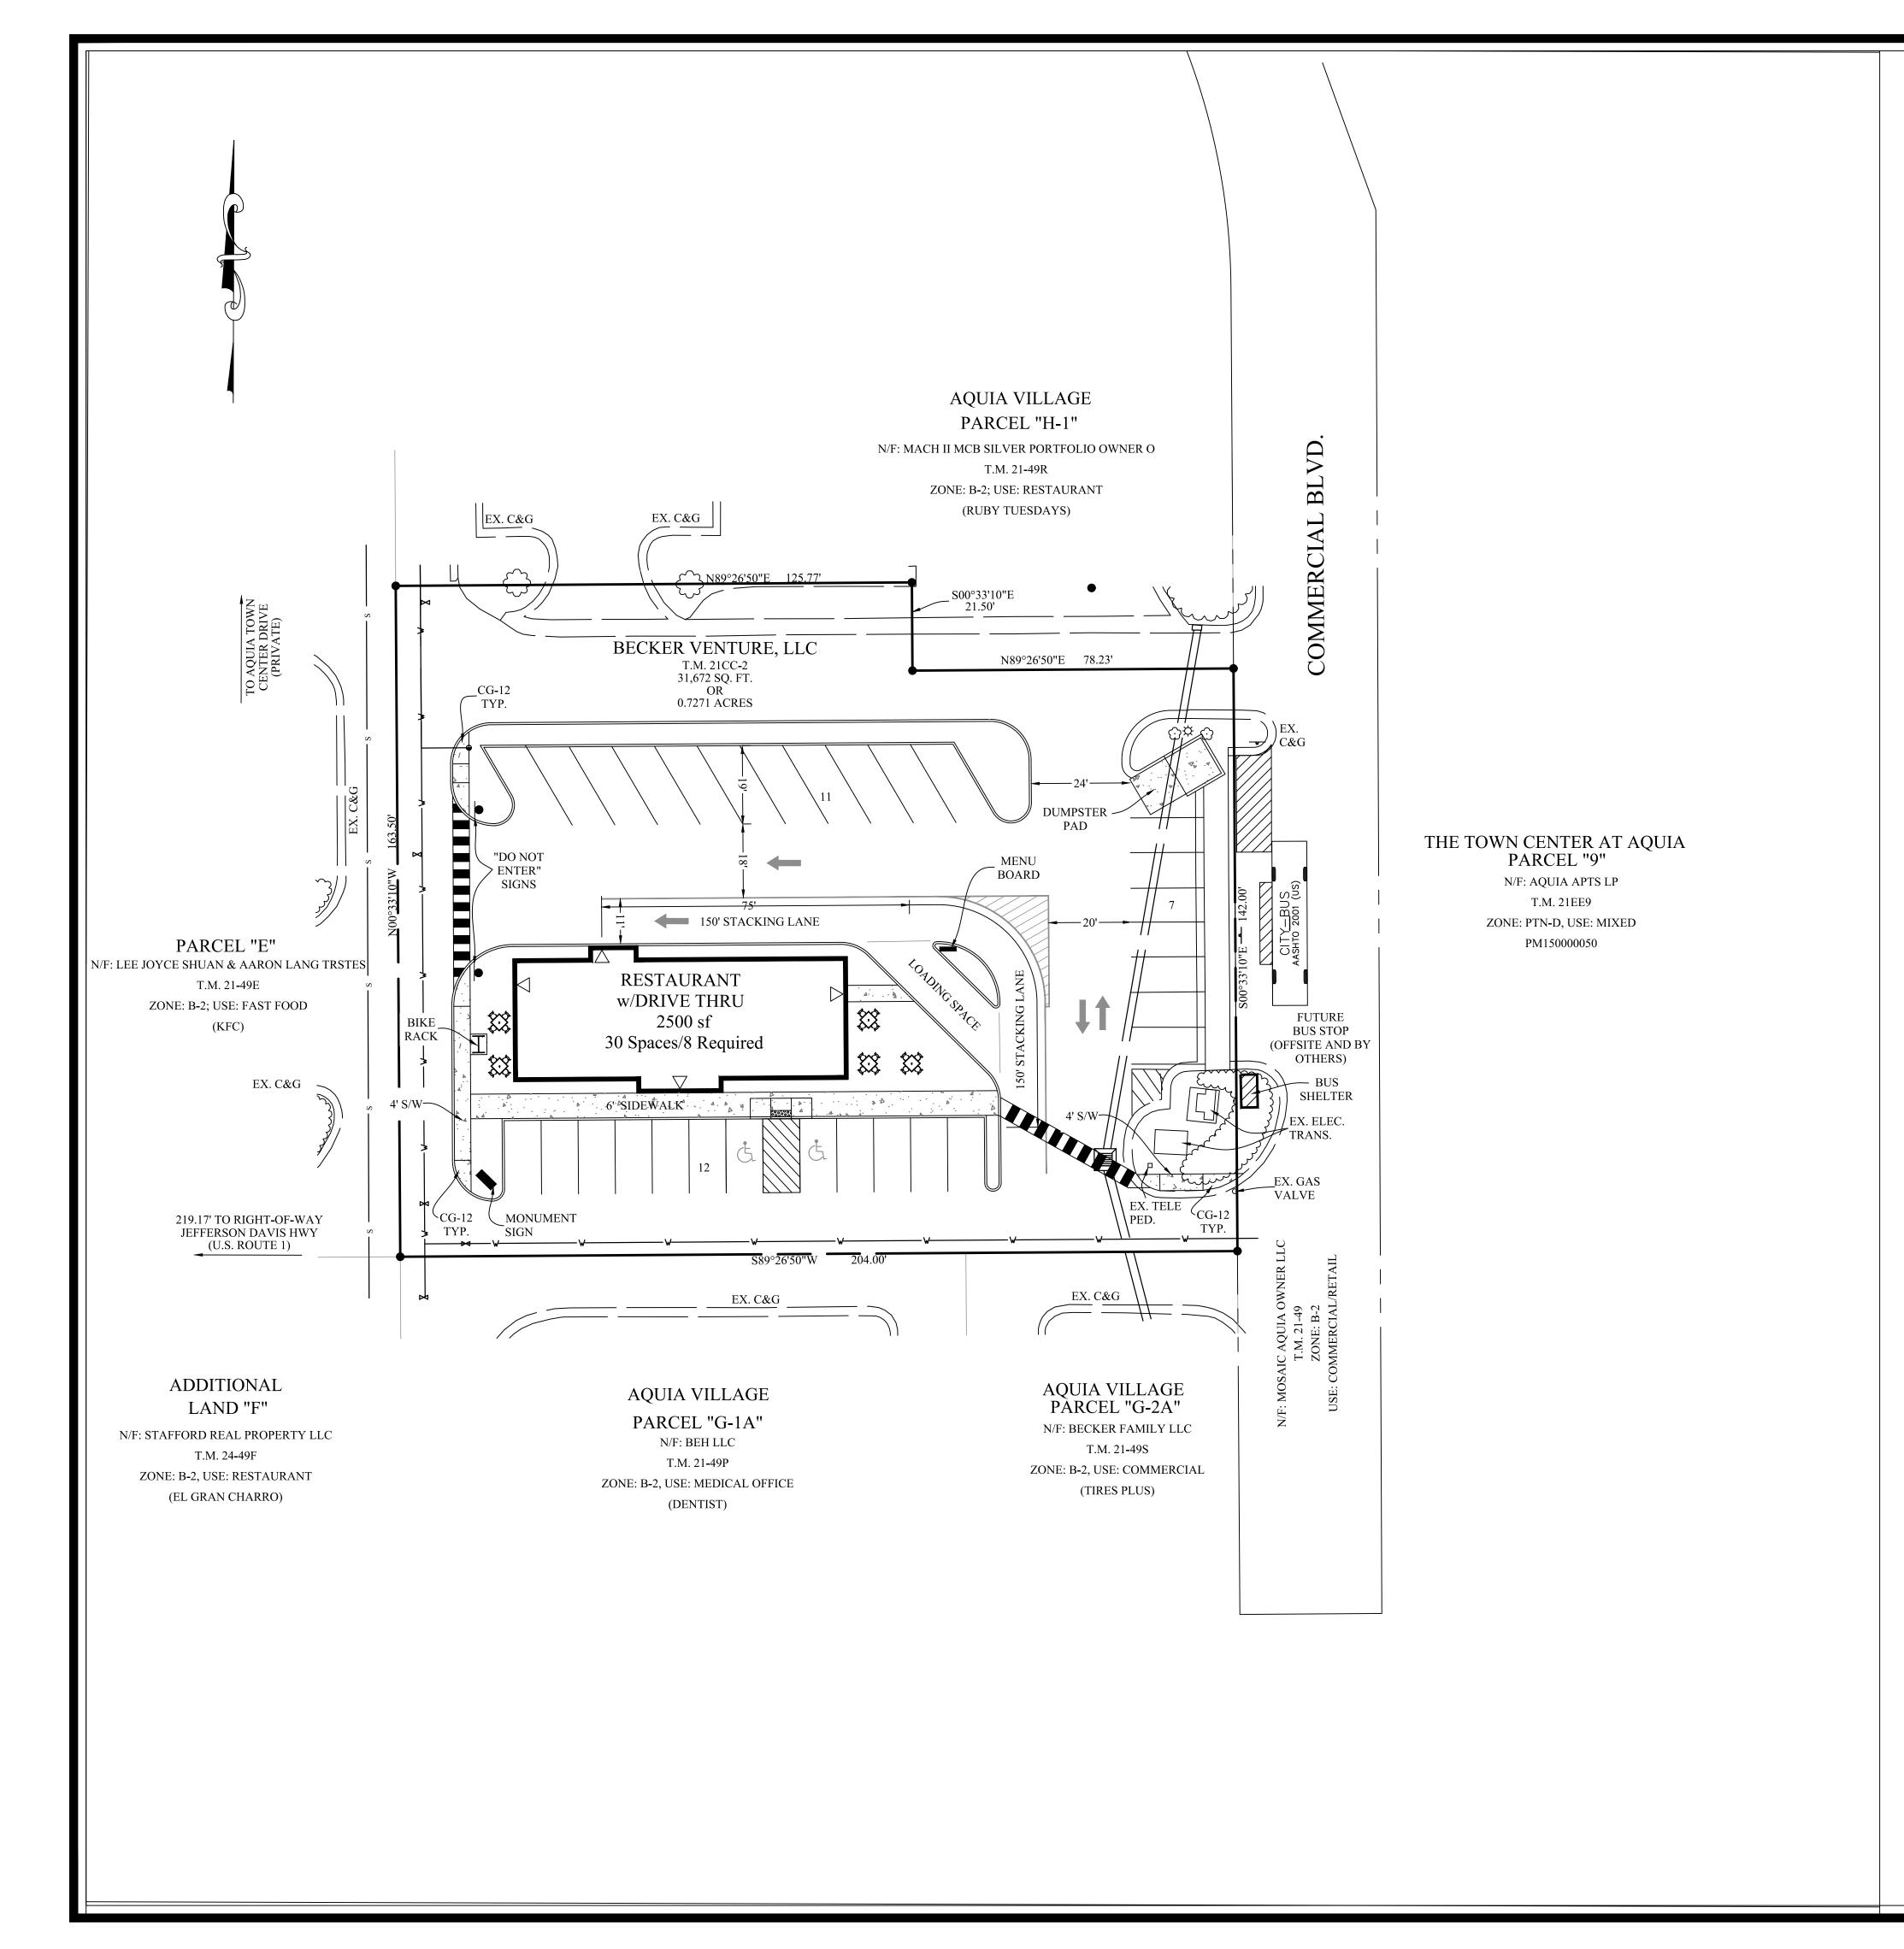

STAFFORD P-TND ZONING DISTRICT REGULATIONS PROJECT NAME TOWN CENTER @ AQUIA 2840 JEFFERSON DAVIS HIGHWAY

SITE CALCULATIONS

TOTAL SITE AREA (BEFORE DEDICATION): 0.72709-ACRES OR 31,672-SQUARE FEET

CONDITIONAL USE AREA

ACRES: 0.72709 SQUARE FEET: 31,672 FLOOR AREA RATIO (P-TND AREA): N/A

OPEN SPACE RATIO (P-TND AREA): 0.05 OR 1,584-SQUARE FEET (MINIMUM)

BUILDING SETBACKS

FRONT: 0-FEET 0-FEET 0-FEET

**BUILDING HEIGHT** 

PERMITTED: PARKING REQUIREMENTS

PARKING (EATING ESTABLISHMENTS):

TOTAL PARKING REQUIRED PARKING PROVIDED: LOADING SPACES:

1 SPACE [12'x25'] 0-7,500 GFA (CUP) 1 SPACE [12'x25'] LOADING SPACES PROVIDED: 2 SPACES HANDICAPPED SPACES REQUIRED:

HANDICAPPED SPACES PROVIDED: 2 SPACES 1 SPACE PER 8 HANDICAPPED SPACES (2 MINIMUM) VAN ACCESSIBLE SPACES:

8-SPACES

2 SPACES VAN ACCESSIBLE SPACES PROVIDED:

**BULK REGULATIONS** 

TOTAL BUILDING SQUARE FOOTAGE: 2,500-SQ. FT. PROPOSED FAR: PROPOSED O.S. 16.4% = (5,205/31,672)

CONTACT CONTACT: BAGBY, FOROUGHI & GOODPASTURE, PLLC

RYAN K FOROUGHI, PE

75-FEET (X<=35' ONE-STORY PROPOSED)

30 SPACES (INCLUDES 2 HANDICAPPED)

3.0 SPACES PER 1,000 GROSS FLOOR AREA (2,500-SF)

(540) 373-5178






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GRAPHIC SCALE

PLAN NO.



SCHEDULE A 5' BUFFER AREA PLANTING 1) MINIMUM REQUIRED BUFFER AREA: (WEST ACCESS DRIVE) 2) MINIMUM WIDTH OF LANDSCAPED YARD: 5-FT. 3) LINEAR FEET OF BUFFER STRIP REQUIRED ALONG PROPERTY LINE AND/OR RIGHT-OF-WAY: 164-FT. 4) PERCENTAGE OF REQUIRED BUFFER AREA OCCUPIED BY EXISTING WOODLAND: 0% 5) FENCE OR WALL OR BERM EMPLOYED IN BUFFER AREA: 6) TOTAL NUMBER OF PLANT UNITS REQUIRED IN BUFFER STRIP: <u>2</u> X 10 P.U. = <u>20</u> P.U. 7) NUMBER OF SHADE TREES PROVIDED: <u>3</u> X 7 P.U. = <u>21</u> P.U. NUMBER OF EVERGREEN TREES: X 7 P.U. = P.U. 16 X 1 P.U. = 16 P.U. NUMBER OF ORNAMENTAL TREES: NUMBER OF SHRUBS: 8) TOTAL NUMBER OF PLANT UNITS PROVIDED IN BUFFER STRIP:
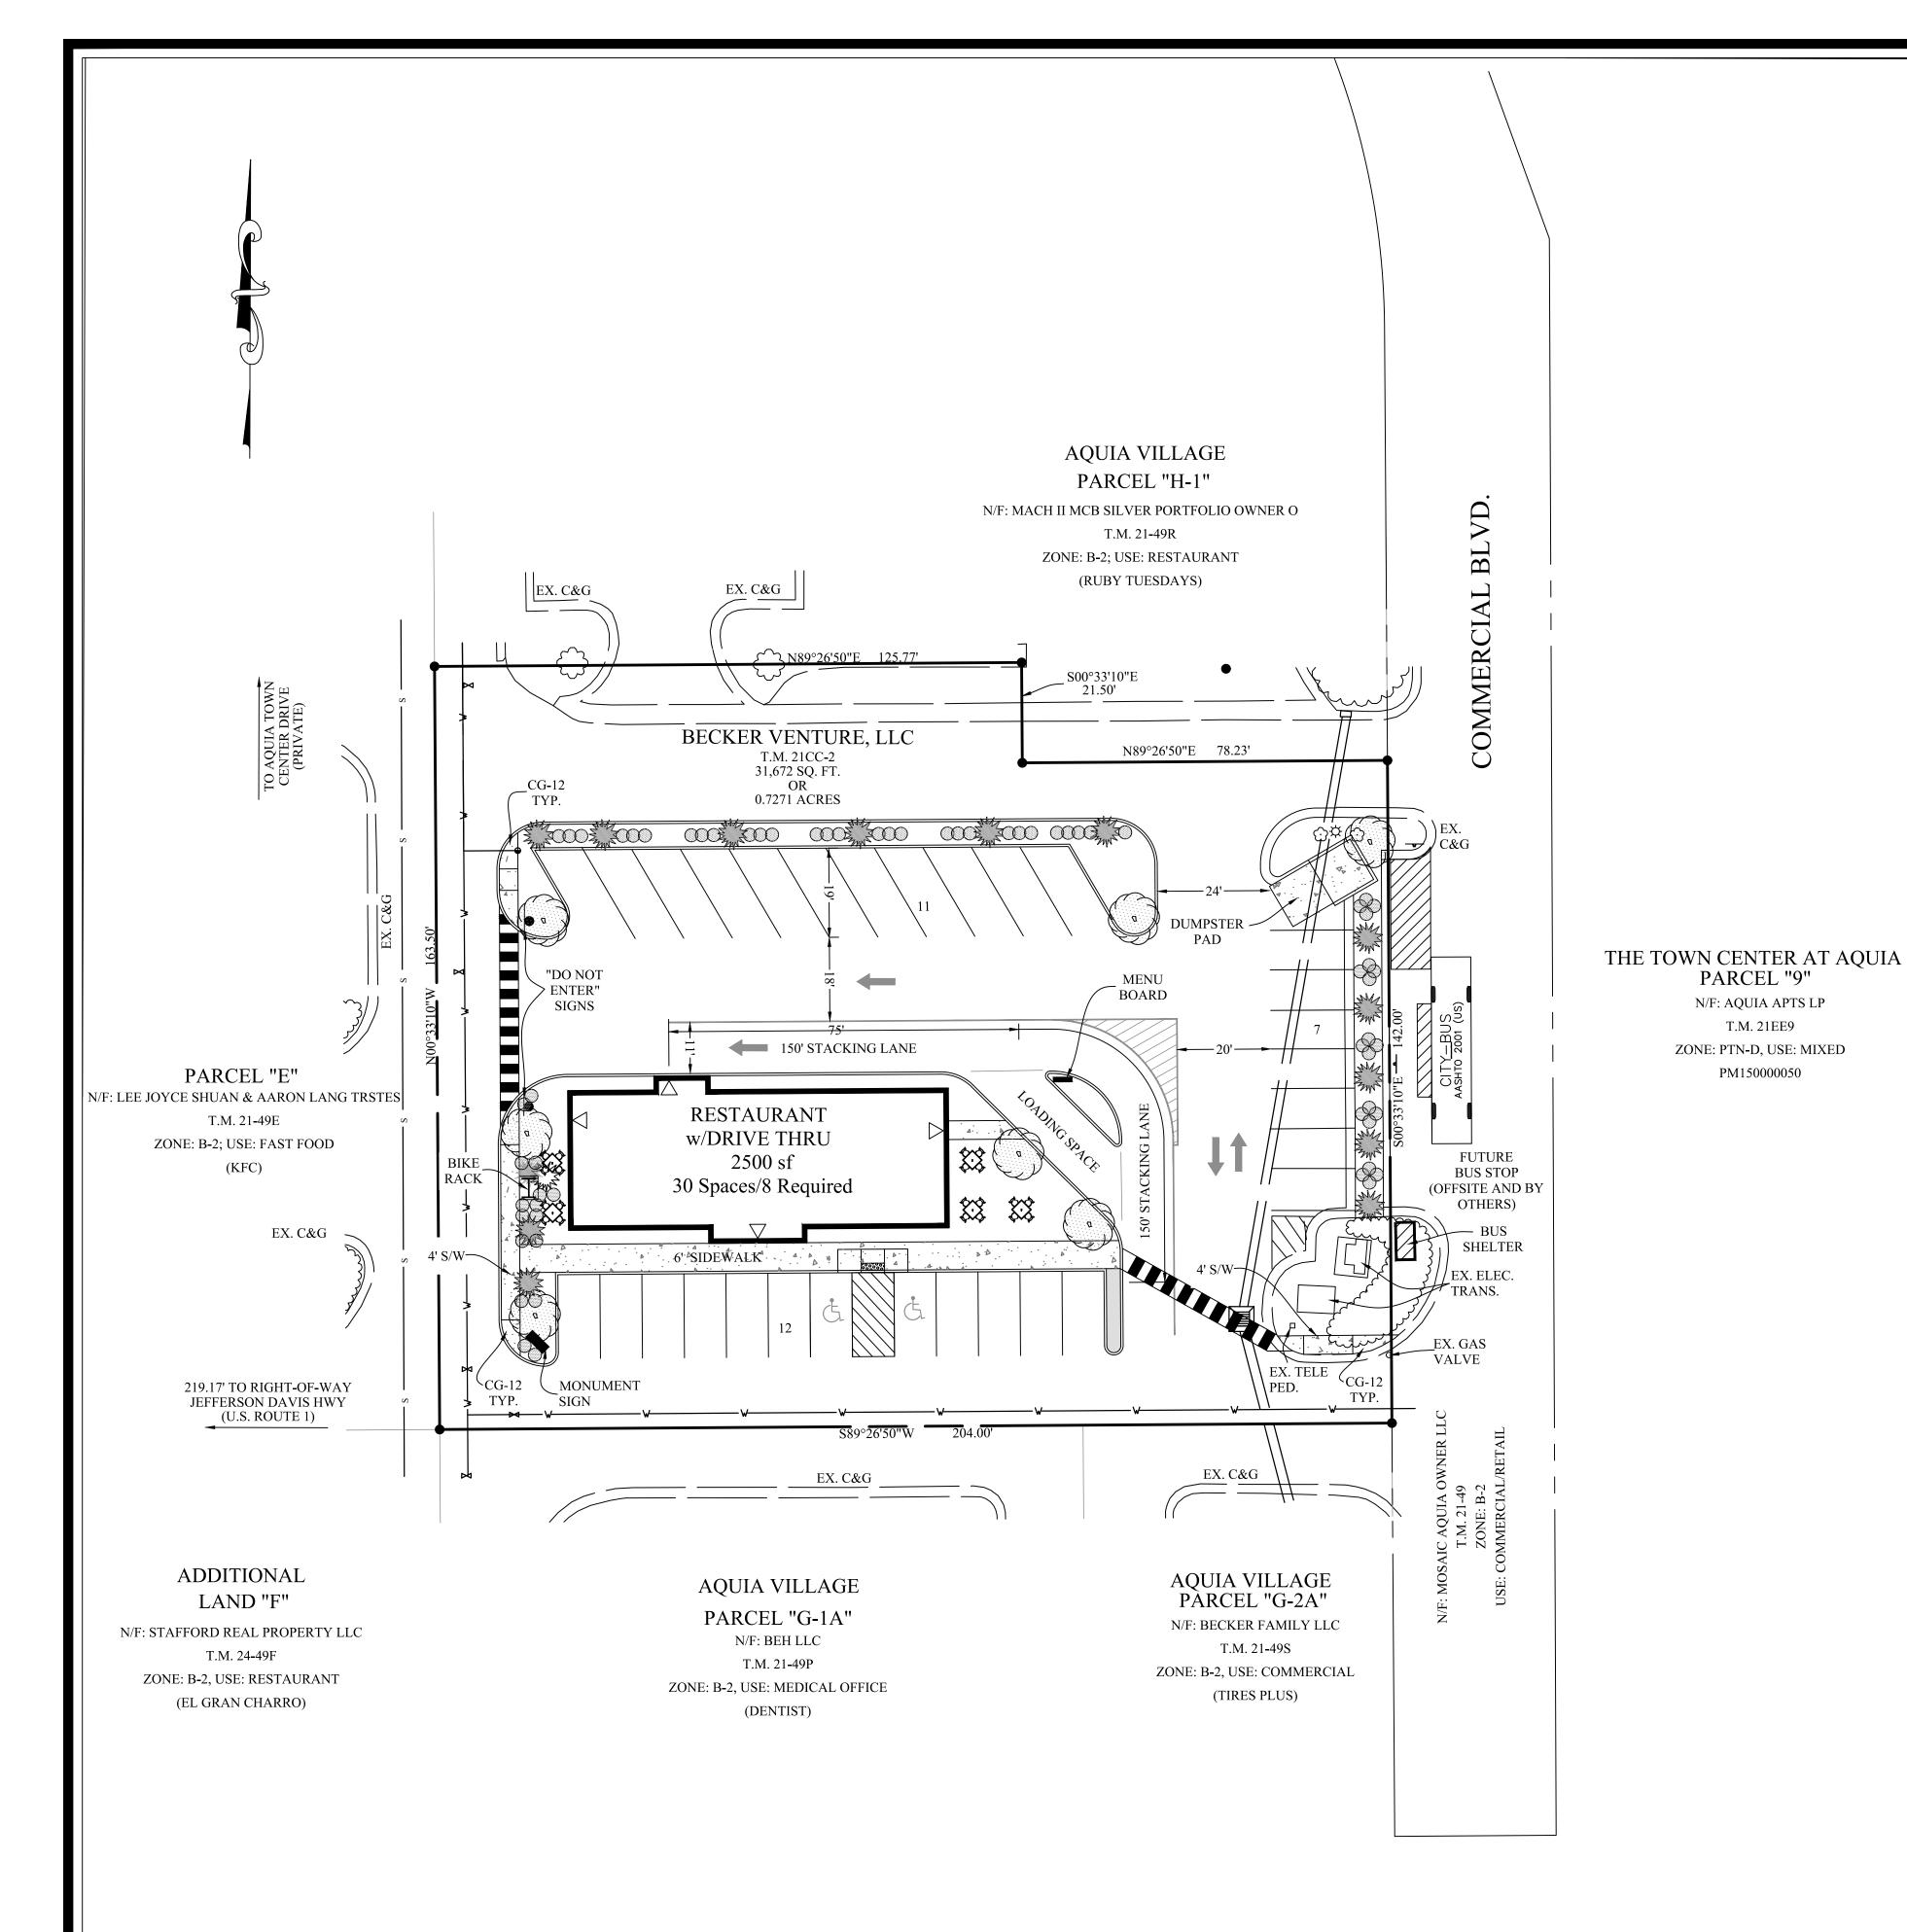
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⊢ SCHEDULI	$\Xi \mathbf{B}$	
5' BUFFER AREA PL	ANTING	
1) MINIMUM REQUIRED BUFFER AREA: (NORT	TH ACCESS DRIVE)	
2) MINIMUM WIDTH OF LANDSCAPED YARD:	5-FT.	
3) LINEAR FEET OF BUFFER STRIP REQUIRED ALC AND/OR RIGHT-OF-WAY: 203-FT.	ONG PROPERTY LINE	
4) PERCENTAGE OF REQUIRED BUFFER AREA OCC WOODLAND: 0%	CUPIED BY EXISTING	
5) FENCE OR WALL OR BERM EMPLOYED IN BUFF	FER AREA:	YES X NO
6) TOTAL NUMBER OF PLANT UNITS REQUIRED IN	N BUFFER STRIP:	<u>71</u> P.U.
7) NUMBER OF SHADE TREES PROVIDED: NUMBER OF EVERGREEN TREES: NUMBER OF ORNAMENTAL TREES: NUMBER OF SHRUBS:	X 10 P.U. =  X 7 P.U. =  X 7 P.U. =  X 7 P.U. =  Y 1 P.U. =	P.U. 42 P.U. P.U. 29 P.U.
8) TOTAL NUMBER OF PLANT UNITS PROVIDED IN	N BUFFER STRIP:	71

SCHEDU: 5' BUFFER AREA			
1) MINIMUM REQUIRED BUFFER AREA: (EA	ST ACCESS DRIVE)		
2) MINIMUM WIDTH OF LANDSCAPED YARD:	5-FT.		
3) LINEAR FEET OF BUFFER STRIP REQUIRED A AND/OR RIGHT-OF-WAY: 163-FT.	LONG PROPERTY LINE		
4) PERCENTAGE OF REQUIRED BUFFER AREA ( WOODLAND: 0%	OCCUPIED BY EXISTING		
5) FENCE OR WALL OR BERM EMPLOYED IN BU	JFFER AREA:	_YES	_X_NO
6) TOTAL NUMBER OF PLANT UNITS REQUIRED	<u>57</u>	_ P.U.	
7) NUMBER OF SHADE TREES PROVIDED: NUMBER OF EVERGREEN TREES: NUMBER OF ORNAMENTAL TREES: NUMBER OF SHRUBS:	1 X 10 P.U. = 5 X 7 P.U. = X 7 P.U. = 20 X 1 P.U. =	10 35 20	P.U. P.U. P.U. P.U. P.U.
8) TOTAL NUMBER OF PLANT UNITS PROVIDED	IN BUFFER STRIP:	65	

PARCEL "9"

N/F: AQUIA APTS LP T.M. 21EE9

PM150000050

	DULE E TERIOR PLANTING
1) NUMBER OF PARKING SPACES PROVIDED: 30	
3) NUMBER OF CANOPY TREES PROVIDED:	FT. x 30 = 900 SQ. FT. x (12PU / 300 SQ. FT.) = 36 P.U.) 4 x 10 PU = 40 PU
NUMBER OF EVERGREEN TREES PROVIDED: NUMBER OF SHRUBS TREES PROVIDED:	0


	LANDSCAPE LEGEND					
SYMBOL	BOTANICAL NAME	COMMON NAME	SIZE	TYPE	QUANTITY	S.F.
		SHADE TREE	SS			
( RM	QUERCUS ALBA	WHITE OAK	2-1/2"-3" (CAL)	В&В	7	250
		EVERGREEN TR	REES			
VP VP	FOSTER HOLLY	ILEX ATTENUATA	6'-6-1/2' (Ht.)	В&В	14	125
ZW		SHRUBS				
F F	RHODODENDRON CALENDULACEUM	AZEALA	24"-30" CONT.	В&В	65	N/A

# **NOTES:**

- 1. LANDSCAPING SHOWN HEREON SHALL NOT INTERFERE
- WITH PROPOSED PARKING LOT
- 2. LANDSCAPE PLAN IS SUBJECT TO REVIEW AND APPROVAL AT TIME OF SITE PLAN.

GRAPHIC SCALE ( IN FEET ) 1 inch = 20 ft.



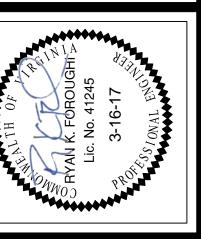

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PLAN NO.